

Appendices

Appendix A – Turkey Point Access Road and Bridge 15% Preliminary Design (Arcadis, 2021)



SOUTHERN PORTS AUTHORITY PORT OF BUNBURY TURKEY POINT ACCESS ROAD & BRIDGE

CITY OF BUNBURY
15% PRELIMINARY DESIGN



Arcadis Australia Pacific Pty Limited
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www.arcadis.com/au


PRELIMINARY ONLY
(NOT FOR CONSTRUCTION)

30093405-AAP-CV100-DRG A


TURKEY POINT ACCESS ROAD AND BRIDGE

SOUTHERN PORTS AUTHORITY

PORT OF BUNBURY

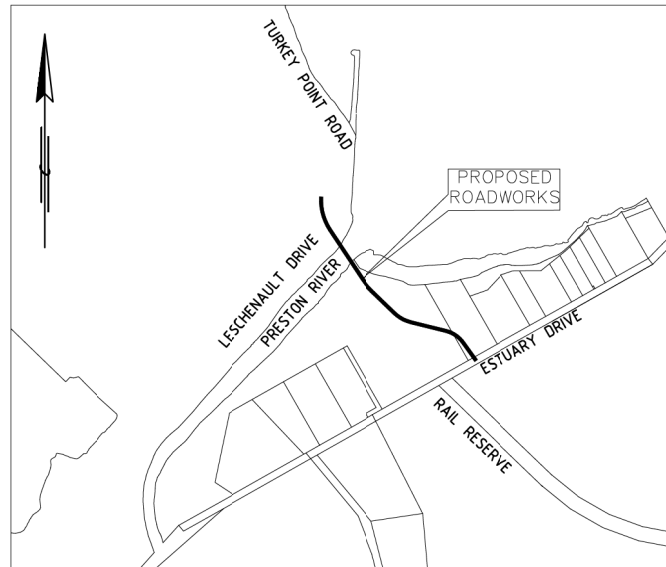

LOCALITY PLAN
NOT TO SCALE

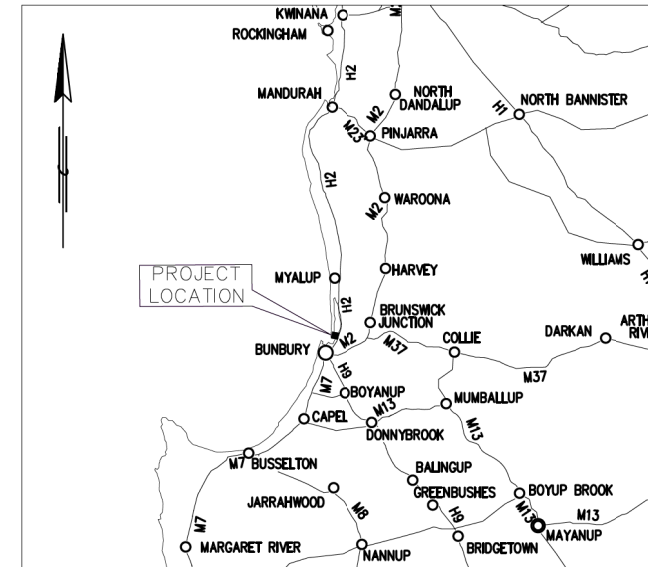

KEY PLAN
NOT TO SCALE

INDEX SHEET

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30093405-AAP-CS100-DRG-102	BRIDGE - SECTIONS

PRELIMINARY PLAN ONLY
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CONSTRUCTION

Issue	Description	Date
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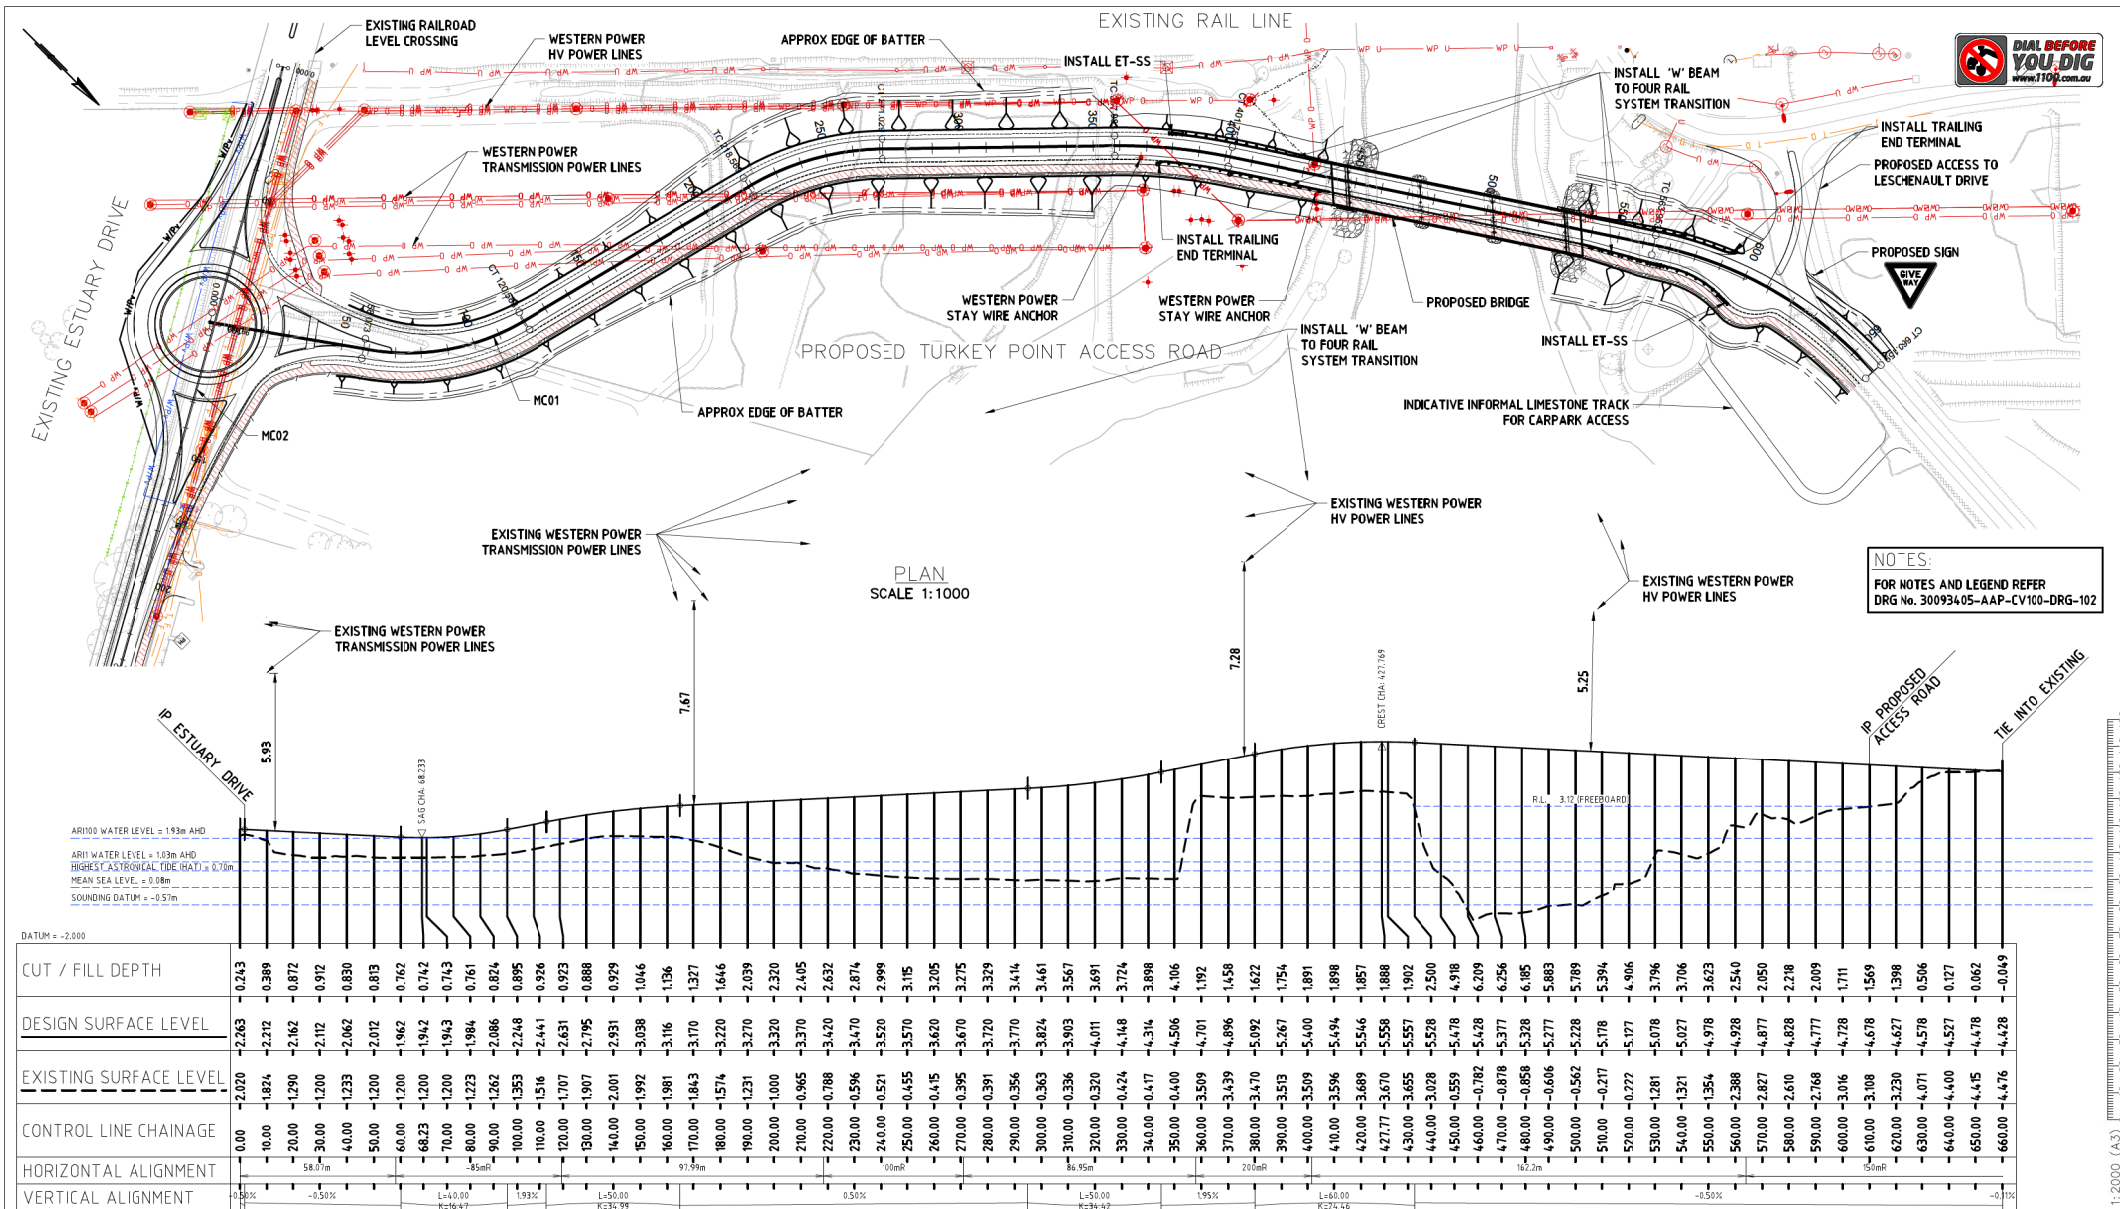
Client



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Height		Checked
Datum		Approved
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Project	SOUTHERN PORTS AUTHORITY PORT OF BUNBURY TURKEY POINT ACCESS ROAD & BRIDGE
Title	TURKEY POINT ACCESS ROAD DRAWING LIST

ARCADIS		
Arcadis Australia Pacific Pty Limited Level 5, 225 St Georges Terrace PERTH WA 6000 ABN 76 104 485 289 Tel No: +61 8 9213 6700 www.arcadis.com.au		
Drawing No.	Project No.	Issue
30093405-AAP-CV100-DRG-002	-	A



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Issue	Description	Date
A	ISSUED TO CLIENT FOR 15% REVIEW	03/06/21

Client

SOUTHERN PORTS AUTHORITY
Port of Bunbury

Status

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Scales

1:1000

Current Issue Signatures

Drawn

Designed

Height

AHD

Datum

AMG

Grid

Filename

Turkey Point_WORKING.dwg

Project

SOUTHERN PORTS AUTHORITY
PORT OF BUNBURY
TURKEY POINT ACCESS ROAD & BRIDGE

Title

ROAD ALIGNMENT
PLAN AND PROFILE

ARCADIS


Arcadis Australia Pacific Pty Limited
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PERTH WA 6000
ABN 76 104 485 289
Tel No: +61 8 9213 6700
www.arcadis.com.au

Drawing No.

Project No.


Issue

30093405-AAP-CV100-DRG-101 - A

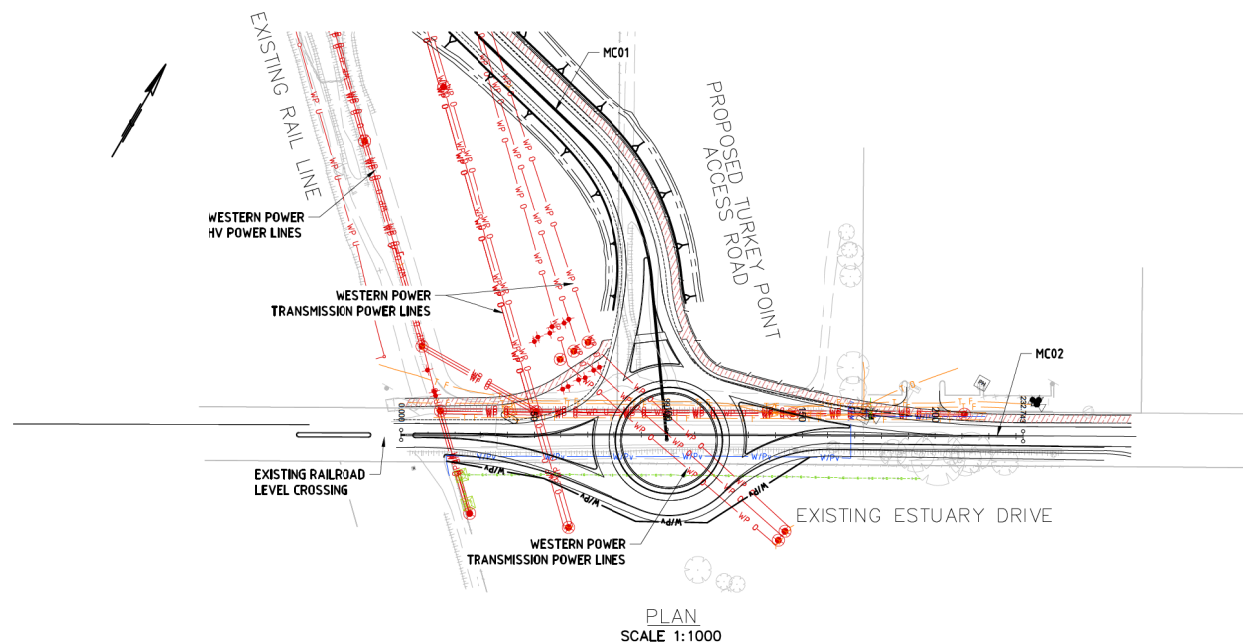

1. ALL DIMENSIONS ARE IN METRES UNLESS NOTED OTHERWISE.
2. THIS DRAWING WAS PRODUCED IN COLOUR AND SHOULD BE PRINTED AS SUCH FOR GREATER CLARITY.
3. DESIGN SPEED;
TURKEY POINT ACCESS ROAD : 60km/h (50km/h POSTED)
ESTUARY DRIVE : 80km/h (70km/h POSTED)
4. DESIGN VEHICLE = 26m B=DOUBLE
5. BARRIER DESIGN SHALL BE READ IN CONJUNCTION WITH MAIN ROADS STANDARD DRAWING NOS. 0330-1666, 0430-2760 TO 0430-0776, 0430-0772 TO 0430-0775, 9548-106 AND 200331-014.

	CADASTRAL BOUNDARY
	EXISTING FENCE
	EXISTING AQUEWATER SUPPLY
	EXISTING TELECOM DISTRIBUTION CABLE
	EXISTING TELECOM OPTIC FIBRE CABLE
	EXISTING WESTERN POWER OVERHEAD
	EXISTING WESTERN POWER UNDERGROUND
	EXISTING ATCO GAS NETWORK
	PROPOSED AQUEWATER SUPPLY
	REFERENCE LINE
	CARRIAGEWAY EDGE LINES
	PROPOSED FRONT OF KERB
	BATTER (1V:3H TYPICAL)
	SHARED PATH
	TABLE DRAIN
	PROPOSED FENCE

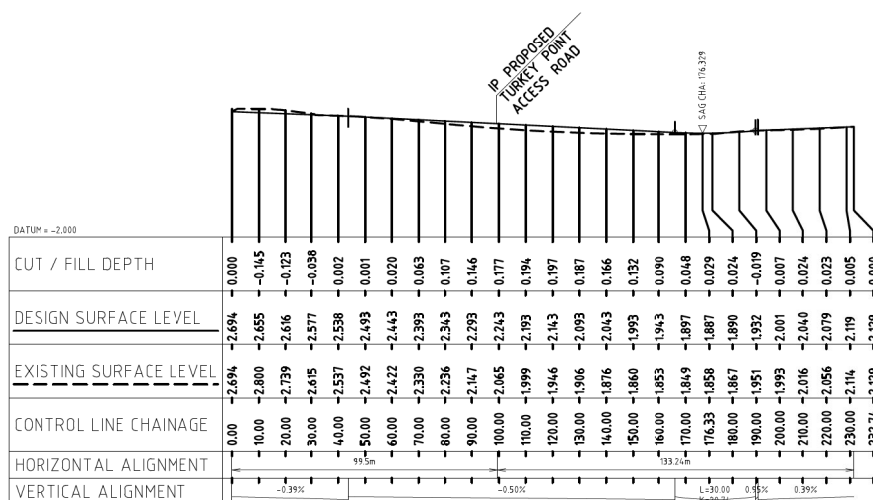

PROFILE MC02
HORIZ 1:1000
VERT 1:100


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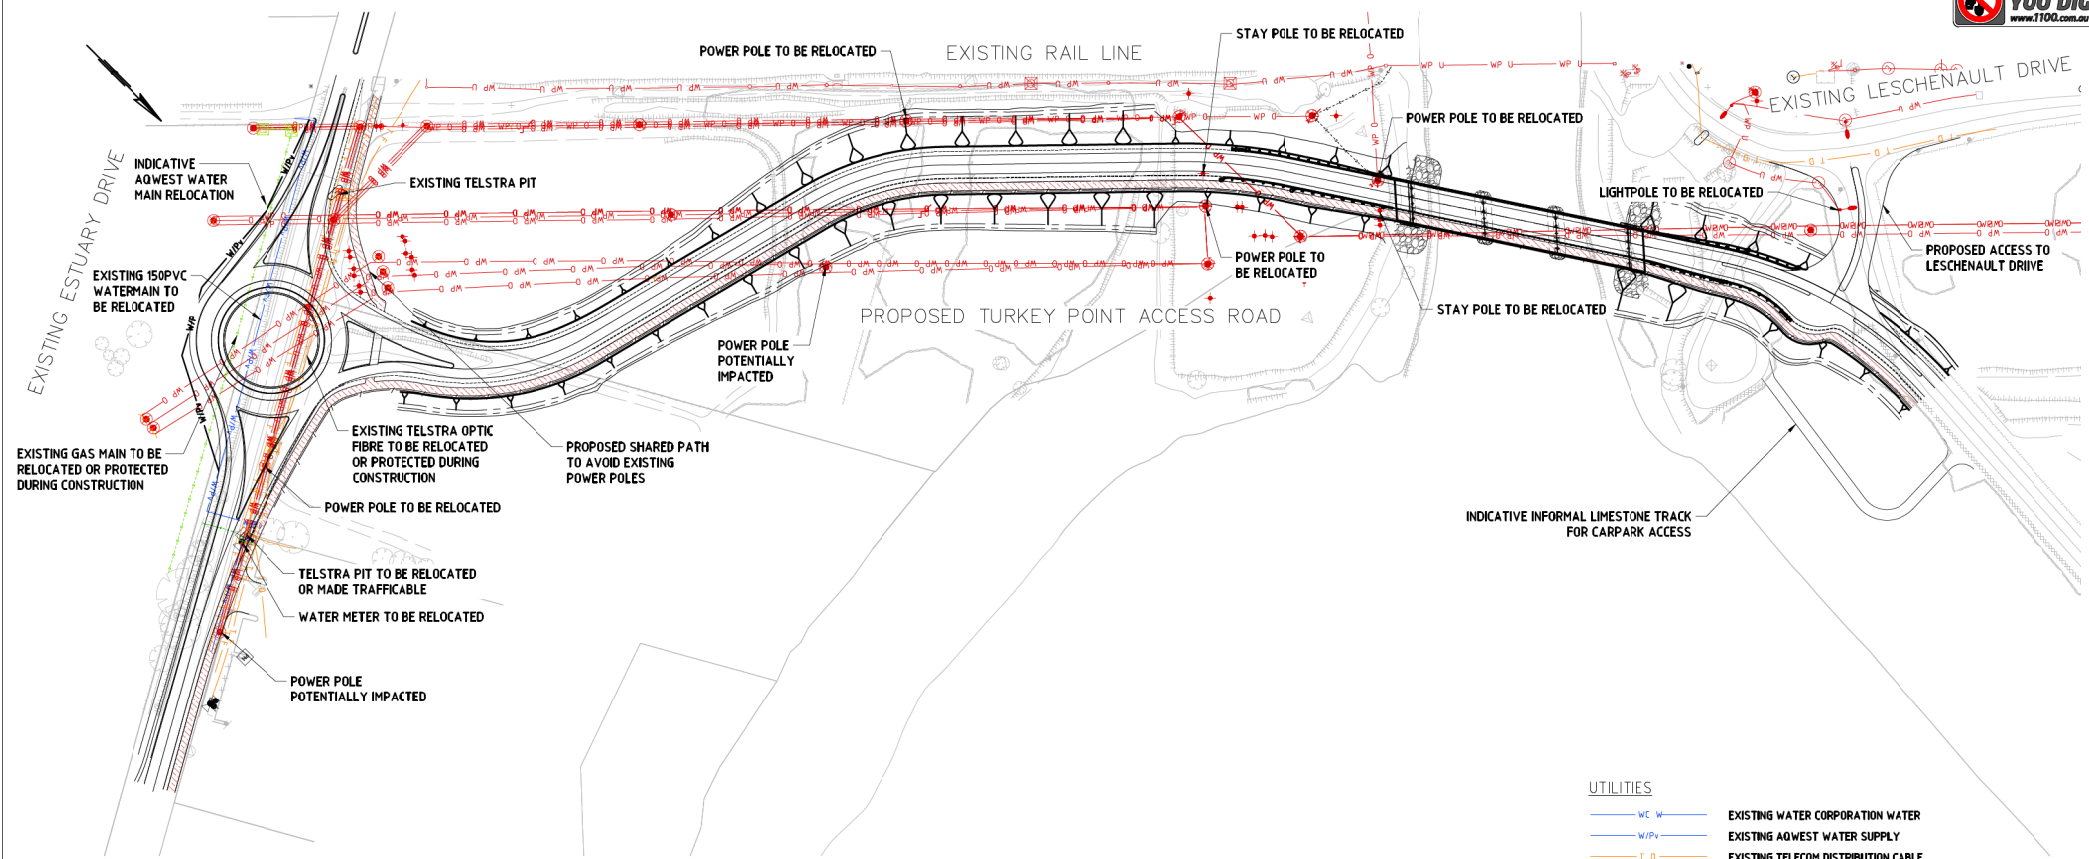
A	ISSUED TO CLIENT FOR 15% REVIEW	03/06/11
Issue	Description	Date



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Grid	AMG	Checked R MCCLDUFF	
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Turkey Point_WORWING.dwg			

Project	SOUTHERN PORTS AUTHORITY PORT OF BUNBURY TURKEY POINT ACCESS ROAD & BRIDGE
Title	ESTUARY DRIVE PLAN AND PROFILE



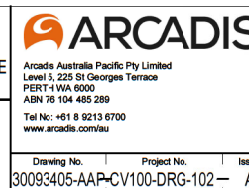

PRELIMINARY PLAN ONLY
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CONSTRUCTION

UTILITIES

- WC W EXISTING WATER CORPORATION WATER
- WPV EXISTING AQWEST WATER SUPPLY
- T D EXISTING TELECOM DISTRIBUTION CABLE
- T F EXISTING TELECOM OPTIC FIBRE CABLE
- WP O EXISTING WESTERN POWER OVERHEAD POWER CABLE
- WP U EXISTING WESTERN POWER UNDERGROUND POWER CABLE
- G EXISTING ATCO GAS NETWORK
- X X X X EXISTING SERVICE TO BE REMOVED
- X EXISTING POWER POLE
- X EXISTING STAY POLE
- X EXISTING LIGHT POLE
- T D PROPOSED TELECOM DISTRIBUTION CABLE
- T F PROPOSED TELECOM OPTIC FIBRE CABLE
- T D / T F PROPOSED TELECOM DISTRIBUTION CABLE AND OPTIC FIBRE CABLE
- WPV PROPOSED AQWEST WATER SUPPLY
- WP O PROPOSED WESTERN POWER OVERHEAD CABLE
- WP U PROPOSED WESTERN POWER UNDERGROUND CABLE
- L PROPOSED LIGHT POLE

Issue	Description	Date
A	ISSUED TO CLIENT FOR 15% REVIEW	03/06/21



Status	FOR INFORMATION ONLY NOT TO BE USED FOR CONSTRUCTION	
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Datum	AMG	Checked R MOLLDOFF
Grid	AMG	Approved D LILLINGWORTH
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Project	SOUTHERN PORTS AUTHORITY PORT OF BUNBURY TURKEY POINT ACCESS ROAD & BRIDGE	
Title	TURKEY POINT ACCESS ROAD UTILITIES PLAN	

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Drawing No.	Project No.	Issue
30093405-AAP-CV100-DRG-111		A



Client

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PORTS
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Port of Bunbury

Project	SOUTHERN PORTS AUTHORITY PORT OF BUNBURY TURKEY POINT ACCESS ROAD & BRIDGE
Title	TURKEY POINT ACCESS ROAD TYPICAL SECTIONS

Date Plotted: 3 Sep 2021 - 09:56AM File Name: C:\Design\Turkey Point Access Rd\03_DRG\Turkey Point WORKING.dwg V



1. ALL ROAD FURNITURE IS NOT SHOWN



Drawing No.	Project No.	Issue
30093405-AAP-CV100-DRG-501		A

100mm on Original



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Project	SOUTHERN PORTS AUTHORITY PORT OF BUNBURY TURKEY POINT ACCESS ROAD & BRIDGE
Title	TURKEY POINT ACCESS ROAD CROSS SECTIONS SHEET 1 OF 10



1. ALL ROAD FURNITURE IS NOT SHOWN




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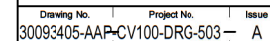
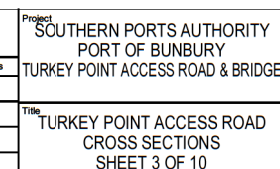




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Title	TURKEY POINT ACCESS ROAD CROSS SECTIONS SHEET 2 OF 10



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1. ALL ROAD FURNITURE IS NOT SHOWN

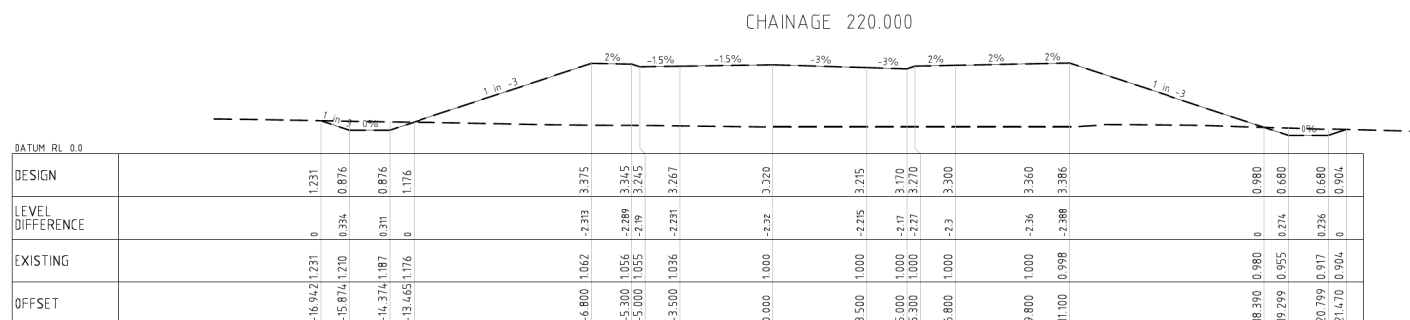


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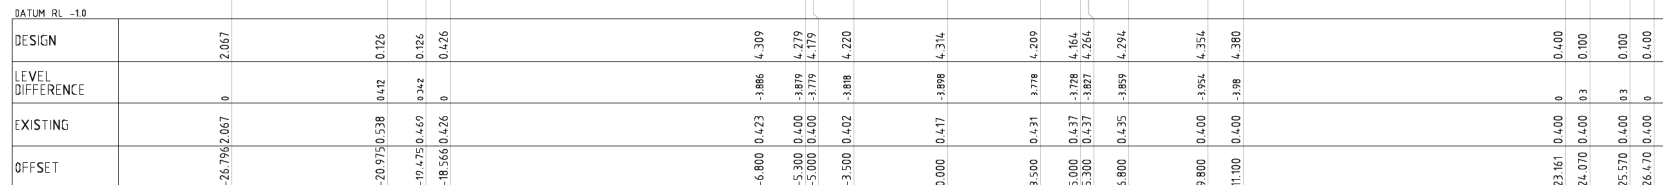

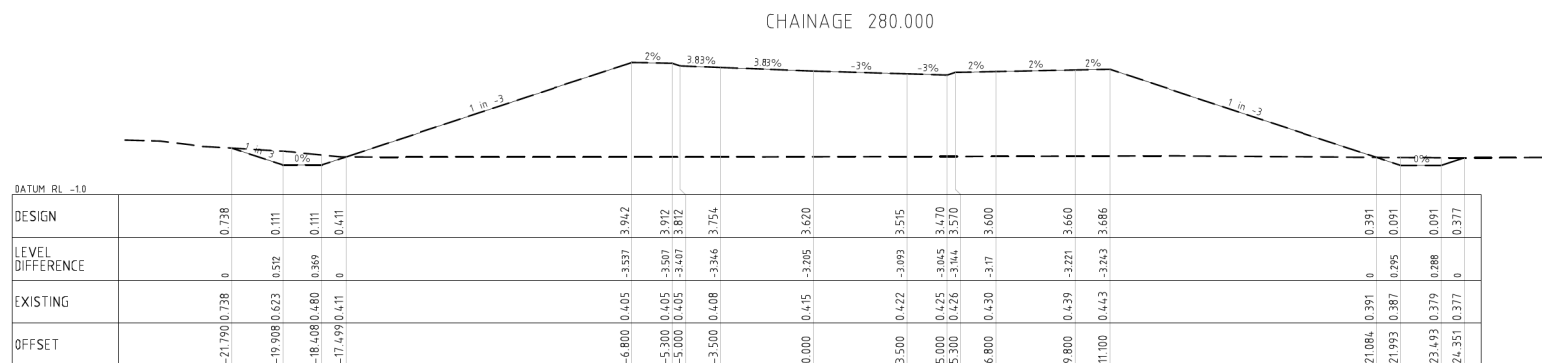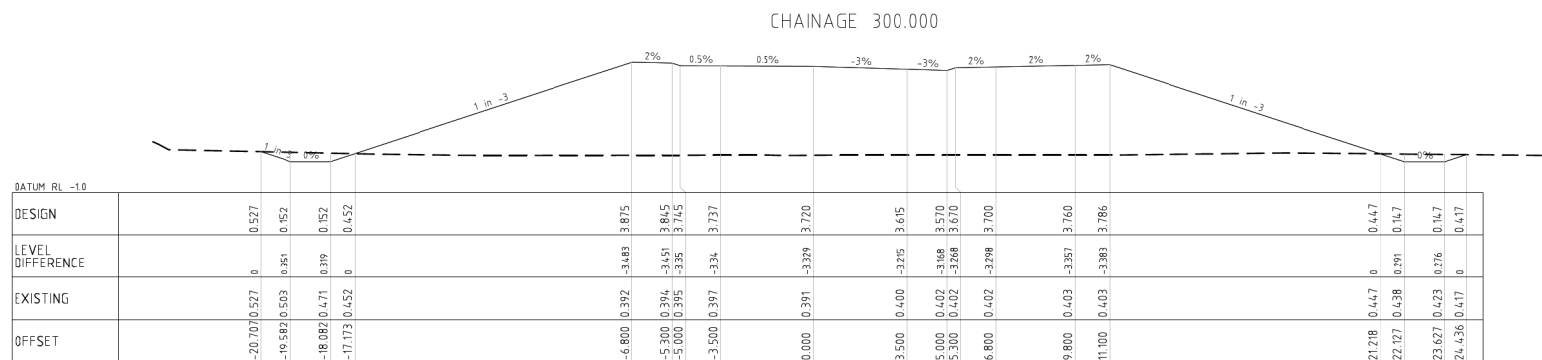
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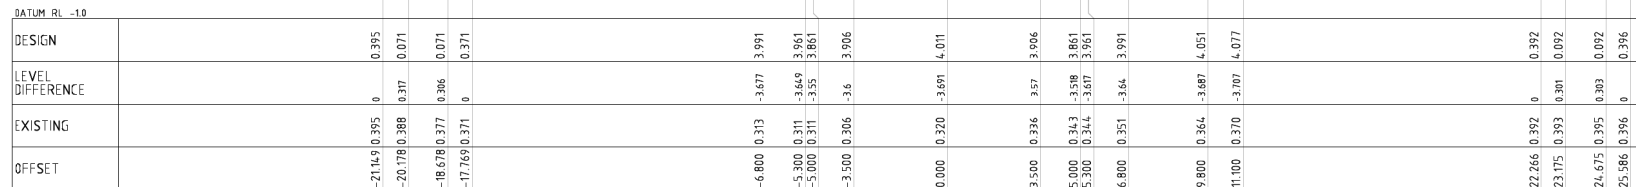
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Title	TURKEY POINT ACCESS ROAD CROSS SECTIONS SHEET 4 OF 10



CHAINAGE 360.000

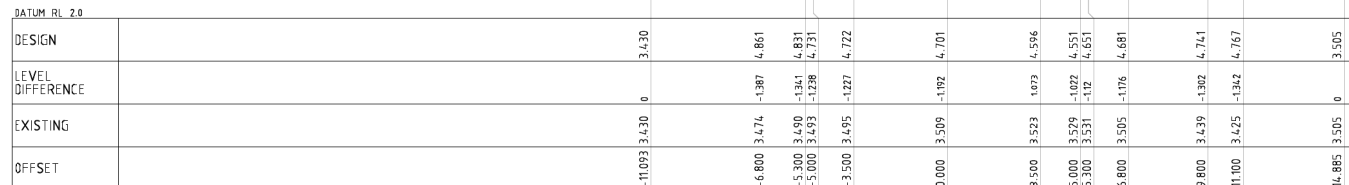

CHAINAGE 340.000



CHAINAGE 320.000

NOTES:

1. ALL ROAD FURNITURE IS NOT SHOWN


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A	ISSUED TO CLIENT FOR 15% REVIEW	03/06/21
Issue	Description	Date



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Title	TURKEY POINT ACCESS ROAD CROSS SECTIONS SHEET 5 OF 10



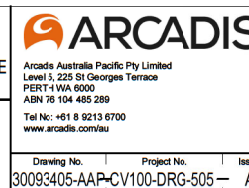


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Drawing No.	Project No.	Issue
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100mm on Original

Title	TURKEY POINT ACCESS ROAD CROSS SECTIONS SHEET 6 OF 10
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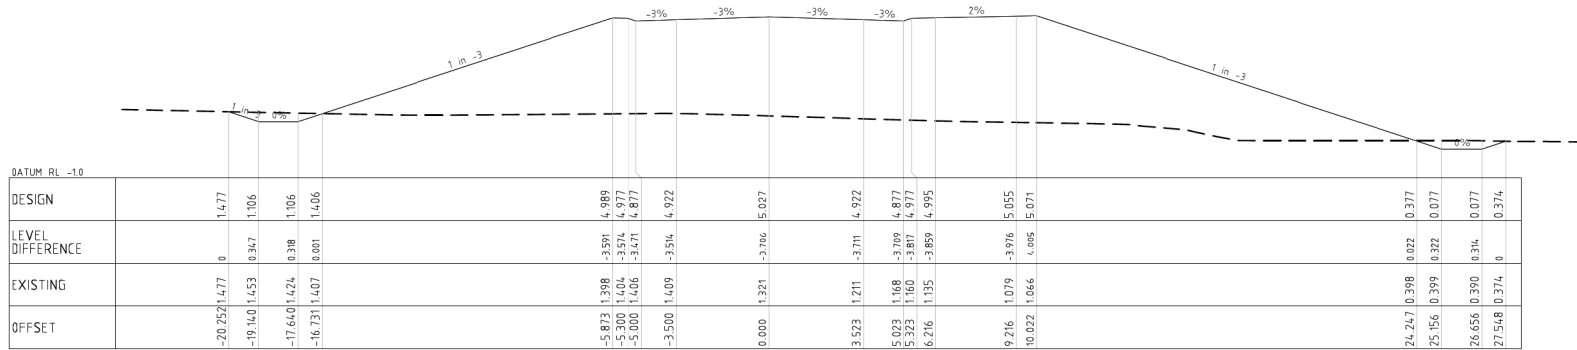
Client

 SOUTHERN
PORTS
AUTHORITY
Port of Bunbury


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Project	SOUTHERN PORTS AUTHORITY PORT OF BUNBURY TURKEY POINT ACCESS ROAD & BRIDGE
Title	TURKEY POINT ACCESS ROAD CROSS SECTIONS SHEET 7 OF 10


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30093405-AAP-CV100-DRG-507		A

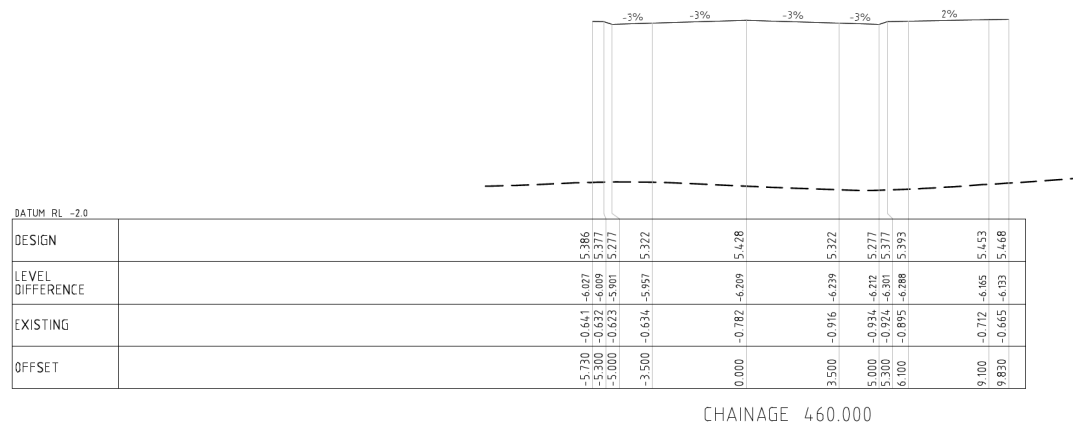

CHAINAGE 540.000

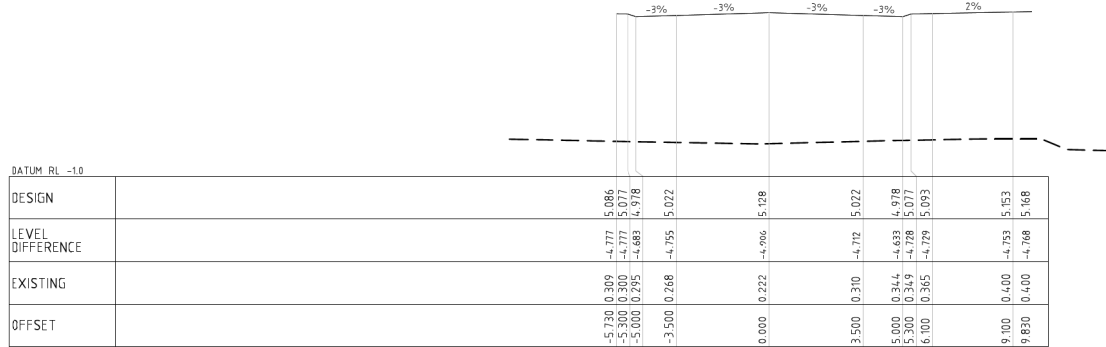

CHAINAGE 520.000

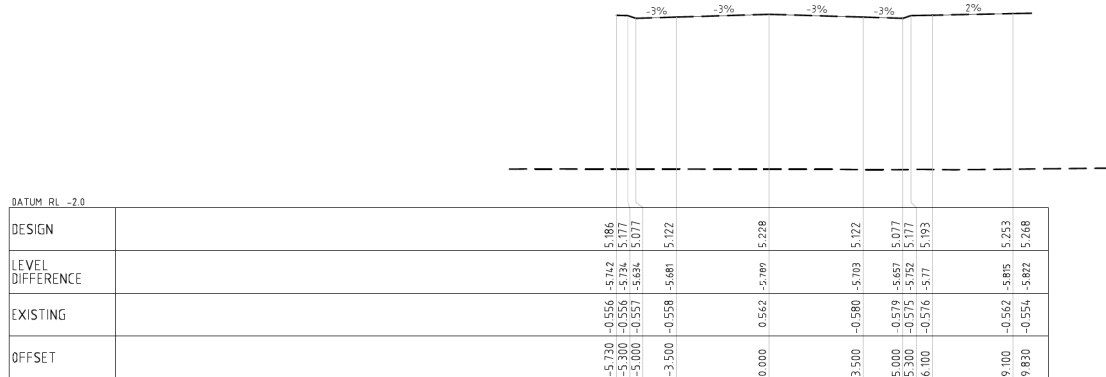

CHAINAGE 500.000

- NOTES:
1. ALL ROAD FURNITURE IS NOT SHOWN
 2. REFER TO BRIDGE DESIGN FOR DETAILS

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NOT TO BE USED FOR
CONSTRUCTION

Issue		Date
A	ISSUED TO CLIENT FOR 15% REVIEW	03/09/21



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SOUTHERN PORTS AUTHORITY PORT OF BUNBURY TURKEY POINT ACCESS ROAD & BRIDGE	
Title	
TURKEY POINT ACCESS ROAD CROSS SECTIONS SHEET 8 OF 10	

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Drawing No.	Project No.
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Drawing No.	Project No.	Issue
30093405-AAP-CV100-DRG-509		A



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Project	SOUTHERN PORTS AUTHORITY PORT OF BUNBURY TURKEY POINT ACCESS ROAD & BRIDGE
Title	TURKEY POINT ACCESS ROAD CROSS SECTIONS SHEET 9 OF 10

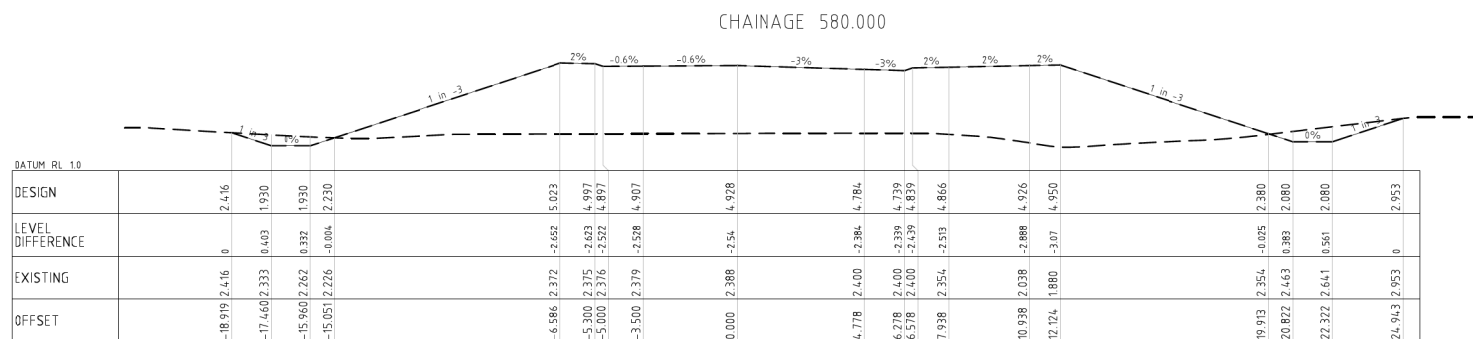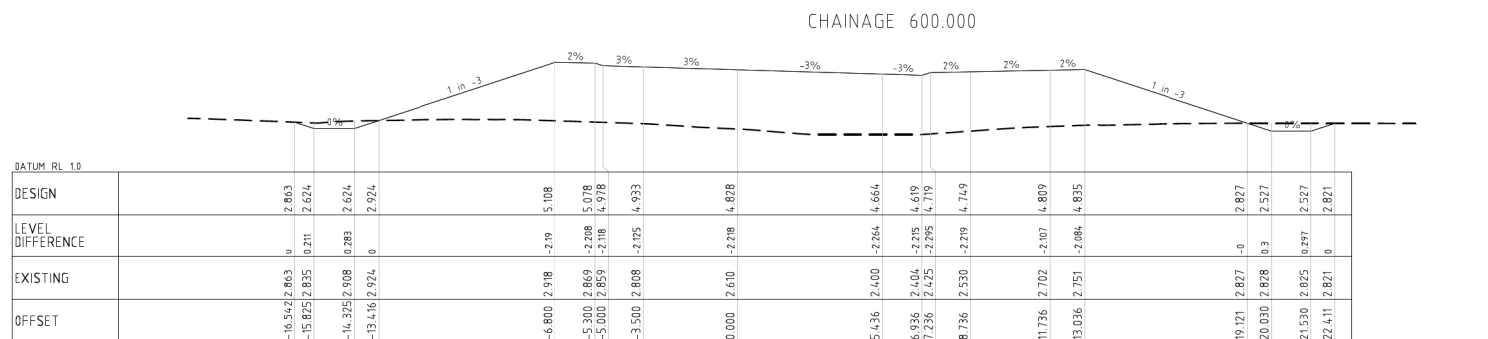

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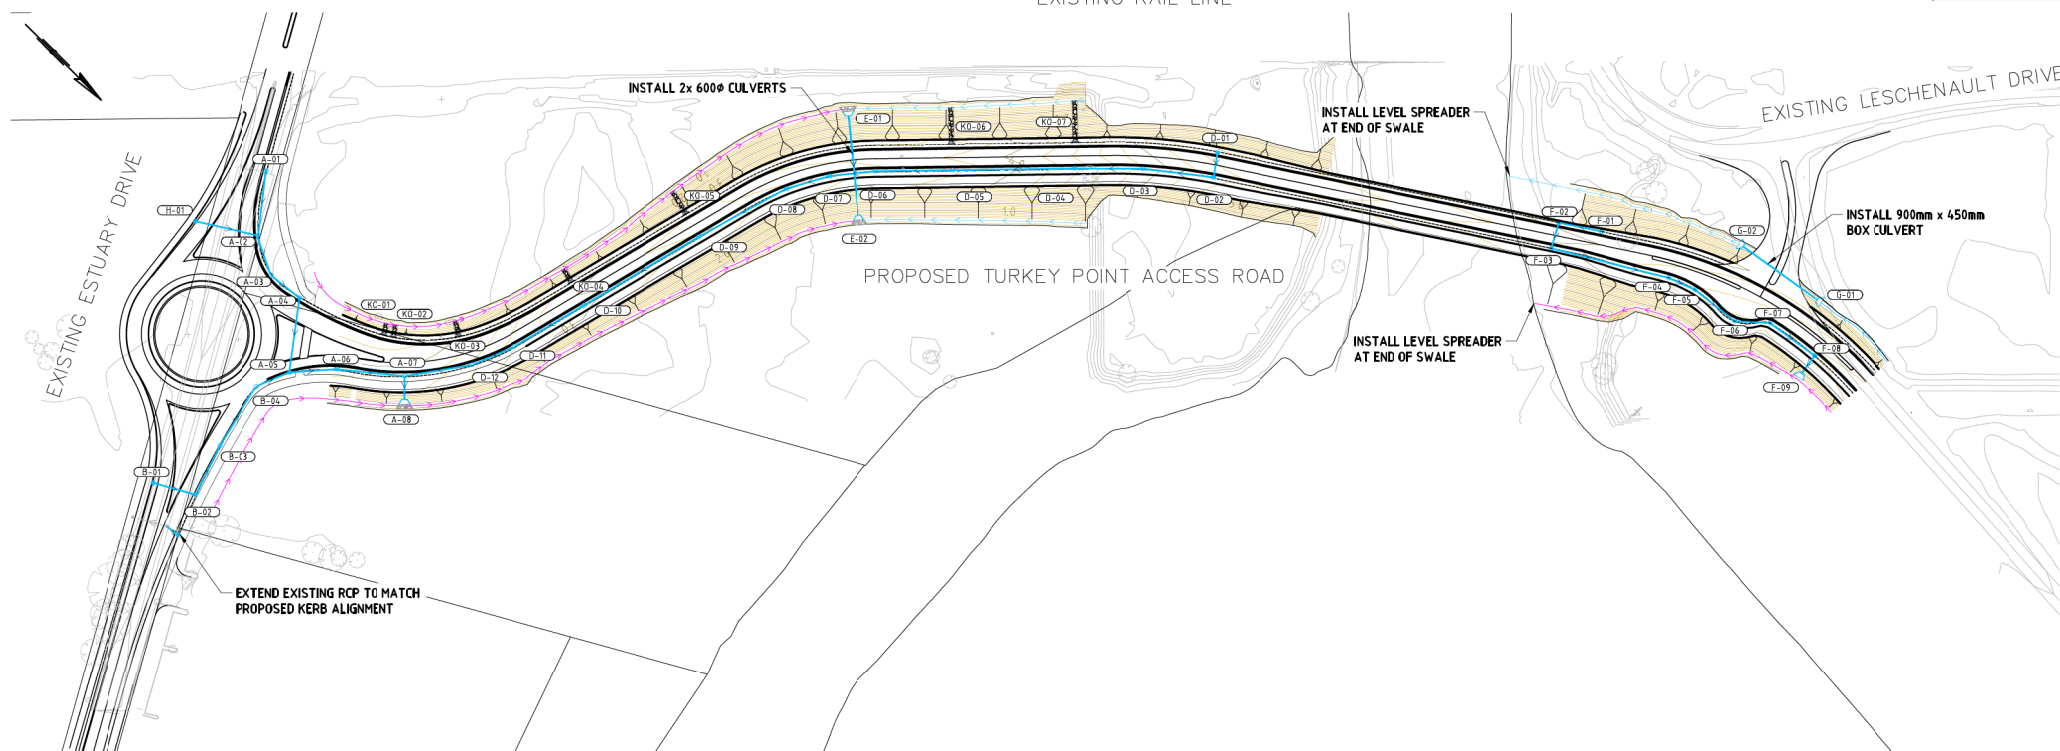
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100mm on Original

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Sheet 15 of 15

EXISTING RAIL LINE




NOTES

1. ALL DIMENSIONS IN METRES UNLESS OTHERWISE SPECIFIED.
2. ALL LEVELS SHOWN ARE BASED ON AHD.
3. ALL INFORMATION FOR EXISTING PITS AND PIPES SHOWN IN THE DRAWING ARE FOR INFORMATION ONLY. THE CONTRACTOR IS TO VERIFY ON SITE PRIOR TO CONSTRUCTION.
4. PROPOSED DRAINAGE INFRASTRUCTURE LOCATIONS ARE INDICATIVE ONLY AND ARE SUBJECT TO CHANGE.
5. FOR STANDARD GRATED PIT STRUCTURE (TGT, SGT) DETAILS, REFER TO MAIN ROADS STANDARD DRG NO. 200231-091
6. FOR STANDARD CULVERT DETAILS, REFER TO MAIN ROADS STANDARD DRG NO. 200131-0065 AND 20131-0066
7. ROCK PITCHING AND BATTER CHUTE DETAILS TO BE PROVIDED AT DETAILED DESIGN
8. BATTER CHUTES MAY BE REQUIRED ALONG SECTIONS OF ROCK PROTECTION WHERE THERE IS A SIGNIFICANT HEIGHT DIFFERENCE BETWEEN THE HINGE AND TOE OF THE BATTER. THIS IS TO BE INVESTIGATED DURING DETAILED DESIGN.
9. ROCK LINING MAY BE REQUIRED AT LOCATIONS WITH SIGNIFICANTLY STEEP CHANNELS. THIS IS TO BE INVESTIGATED DURING DETAILED DESIGN

LEGEND

- | | |
|--|---|
| | PROPOSED TOE OF EMBANKMENT SWALE DRAIN (TYPE 1) |
| | PROPOSED TOE OF EMBANKMENT SWALE DRAIN (TYPE 2) |
| | PROPOSED DRAINAGE PIPE |
| | PROPOSED STREET GULLY, TRAFFICABLE (GT) |
| | PROPOSED MANHOLE, TRAFFICABLE (MH) |
| | PROPOSED HEADWALL |
| | PROPOSED KERB OPENING |
| | PROPOSED ROCK PROTECTION |
| | PROPOSED CONTOURS - MAJOR (1.0m) |
| | PROPOSED CONTOURS - MINOR (0.2m) |
| | SURVEY CONTOURS - MAJOR (0.5m) |
| | EXISTING DRAIN PIPE |
| | BATTER (1v:3H TYPICAL) |

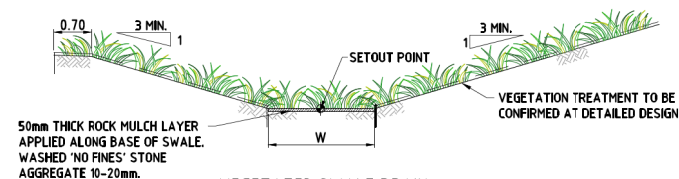

VEGETATED SWALE DRAIN
SCALE 1:50

SWALE DRAIN DIMENSIONS				
TYPE	D (mm)	W (mm)	BATTER SLOPE (1:X)	PROPOSED TOE EMBANKMENT SW
1	300	1500	3	TYPE 1
2	400	1500	3	TYPE 2

PRELIMINARY PLAN ONLY
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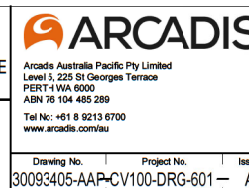
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Issue	Description	Date



Client	
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Status FOR INFORMATION ONLY NOT TO BE USED FOR CONSTRUCTION			
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Project	SOUTHERN PORTS AUTHORITY PORT OF BUNBURY TURKEY POINT ACCESS ROAD & BRIDGE
Title	TURKEY POINT ACCESS ROAD DRAINAGE PLAN



DEVELOPMENT ENVELOPE
APPROX AREA = 67,328m²

A	ISSUED TO CLIENT FOR 15% REVIEW	03/06/21
Issue	Description	Date






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Filename:		Turkey Point_WORKING.dwg	

Title	TURKEY POINT ACCESS ROAD DEVELOPMENT ENVELOPE
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Drawing No.	Project No.	Issue
30093405-AAP-CV100-DRG-901		A



NOTES

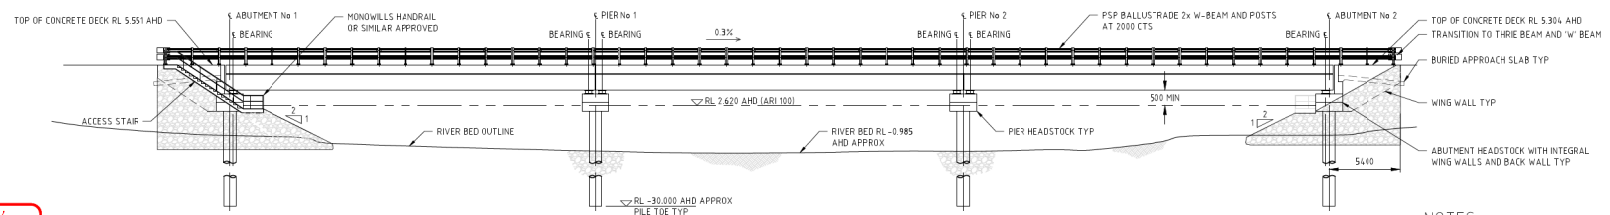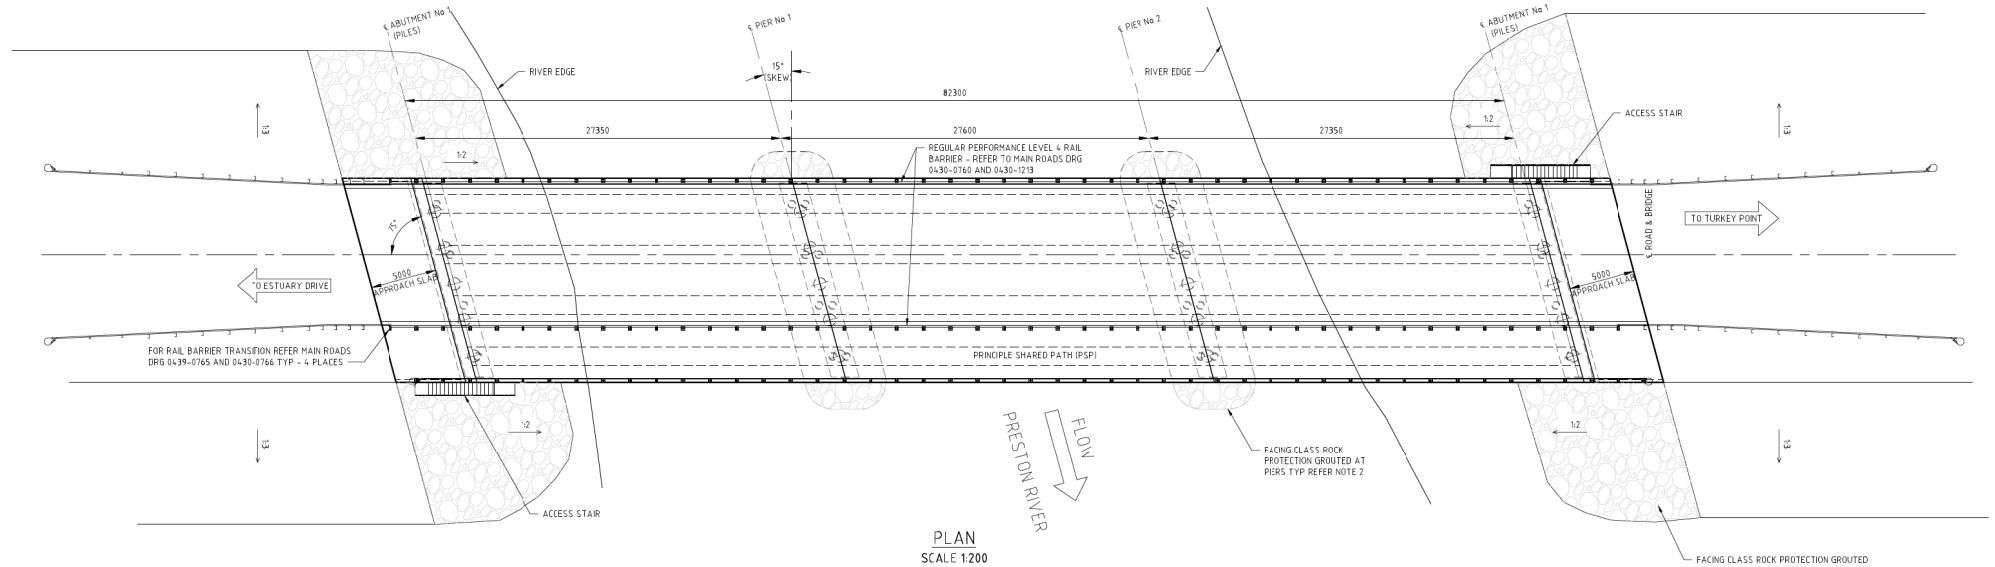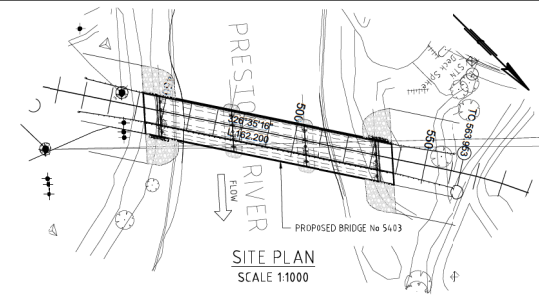- ALL DIMENSIONS ARE IN MILLIMETRES UNLESS NOTED OTHERWISE
- ROCK PROTECTION TO BE IN ACCORDANCE WITH MRWA SPECIFICATION 406 (FACING CLASS 500 THK OVER BDM A4 GEOTEXTILE, GROUTED AT ABUTMENTS USING M4 MORTAR TO AS3700)
- SURFACING TO BE AS PER THE SPECIFICATION AND SHALL CONSIST OF 10mm NOM THK RUBBERISED BITUMEN WATER PROOFING MEMBRANE, DENSE GRADED ASPHALT 40mm THK BITUMENE 5000 STRIPS BENEATH COMBINED KERB AND DRAIN SYSTEM

**INFORMATION ONLY
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CONSTRUCTION**

Issue	Description	Date
A	ISSUED TO CLIENT FOR 15% REVIEW	03.09.21



Status	FOR INFORMATION ONLY NOT TO BE USED FOR CONSTRUCTION
Scales	N/A
Original Size	A1
Height	Designed
Datum	Checked
Grid	Approved
Filename:	30093405-AAP-CS100-DRG-101.dwg


Project
SOUTHERN PORTS AUTHORITY
PORT OF BUNBURY
TURKEY POINT ACCESS ROAD & BRIDGE

Title
TURKEY POINT ACCESS BRIDGE
PLAN AND ELEVATION


ARCADIS

Arcadis Australia Pacific Pty Limited
Level 5, 225 St Georges Terrace
PERTH WA 6000
ABN 76 104 485 289
Tel No: +61 8 9213 6700
www.arcadis.com.au


Drawing No. Project No. Issue
30093405-AAP-CS100-DRG-001 - A

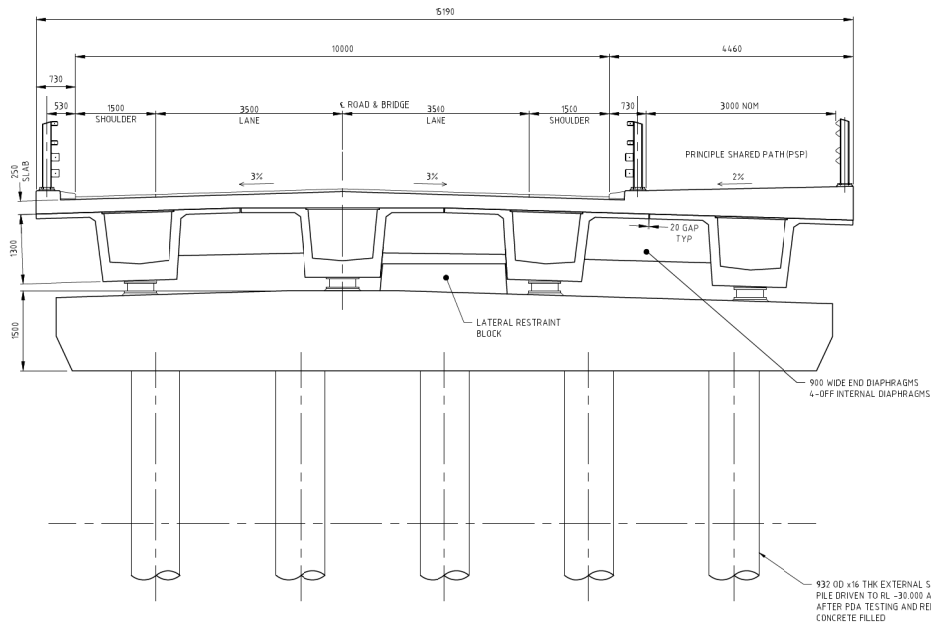

TYPICAL BRIDGE SECTION AT PIER
SCALE 1:50

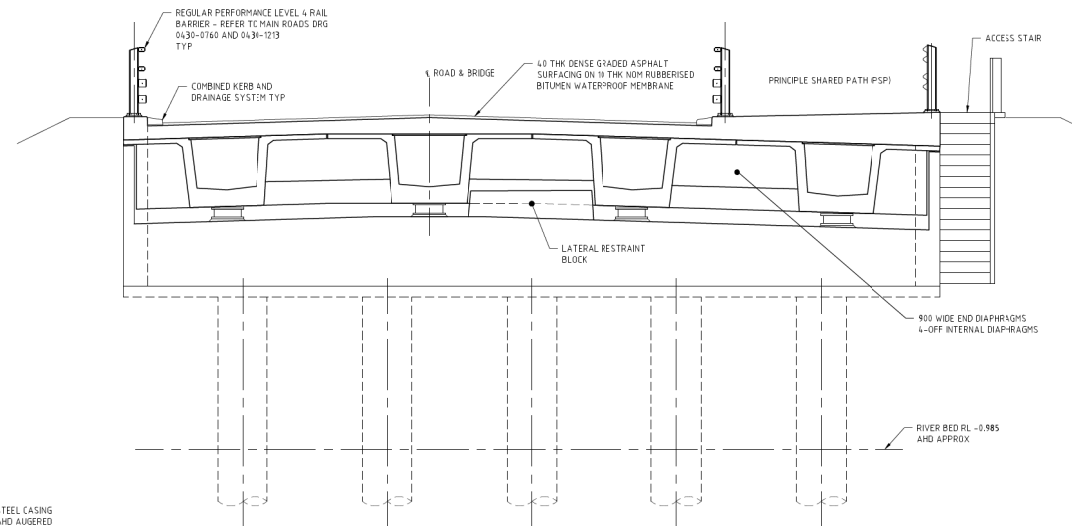

TYPICAL BRIDGE SECTION AT ABUTMENT
SCALE 1:50

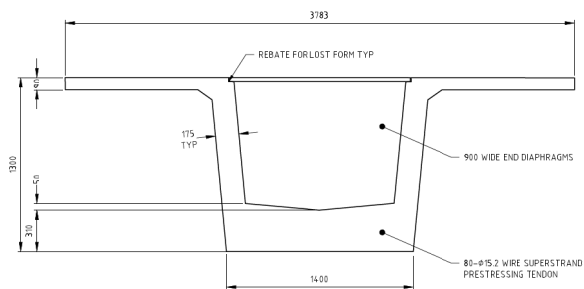

PRECAST BEAM
12-OFF REQUIRED
SCALE 1:20

INFORMATION ONLY
NOT TO BE USED FOR
CONSTRUCTION

NOTES

- MATERIALS:
PRECAST TEEROFF GIRDER: S50 PRESTRESSED CONCRETE
IN-SITU ELEMENT: S40 REINFORCED CONCRETE
- PILES ARE INDICATIVE ONLY, TO BE CONFIRMED AT NEXT STAGE

Issue	Description	Date
A	ISSUED TO CLIENT FOR 15% REVIEW	03.09.21

100mm on Original

Client



Status	FOR INFORMATION ONLY NOT TO BE USED FOR CONSTRUCTION
Scales	N/A
Original Size	A1
Height	Designed
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Grid	Approved
Filename	30093405-AAP-CS100-DRG-101.dwg

Project
SOUTHERN PORTS AUTHORITY
PORT OF BUNBURY
TURKEY POINT ACCESS ROAD & BRIDGE

Title
TURKEY POINT ACCESS BRIDGE
SECTIONS

ARCADIS		
Arcadis Australia Pacific Pty Limited Level 5, 225 St Georges Terrace PERTH WA 6000 ABN 76 104 485 289 Tel No: +61 8 9213 6700 www.arcadis.com/au		
Drawing No.	Project No.	Issue
30093405-AAP-CS100-DRG-002		A

Date Plotted: 3 Sep 2021 - 09:01AM File Name: C:\Users\ed7800\Desktop\TURKEY POINT\AU\TCCAD\30093405-AAP-CS100-DRG-101.dwg V1